


NO.	DATE	PRINTS ISSUED
1	6/1/2010	ISSUE FOR TENDER

NO.	DATE	REVISIONS TO DRAWING
1		

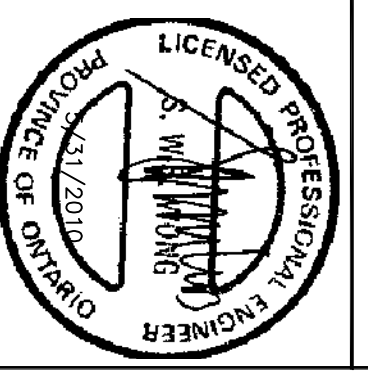

Do not scale drawings. Check and verify all dimensions and report all errors and omissions to the architect before proceeding with the work.

A Detail No.
 B Sheet No. where detailed.

SWS ENGINEERING INC.
 1100 CENTRAL PARKWAY WEST, UNIT 15, 2ND FL.
 MISSISSAUGA, ON L5C 4E5
 TEL: (905) 272-1588 FAX: (905) 272-8254

PROJECT
ATTRIDGE TRANSPORT OFFICE
 4-4100 HARVESTER ROAD
 BURLINGTON, ONTARIO

CLIENT


DRAWING
ROOF PLAN

SCALE 1:100
 DATE APRIL 19, 2010

DRAWN BY LY
 CHECKED BY SW

PROJECT NO. 10072

S2.3

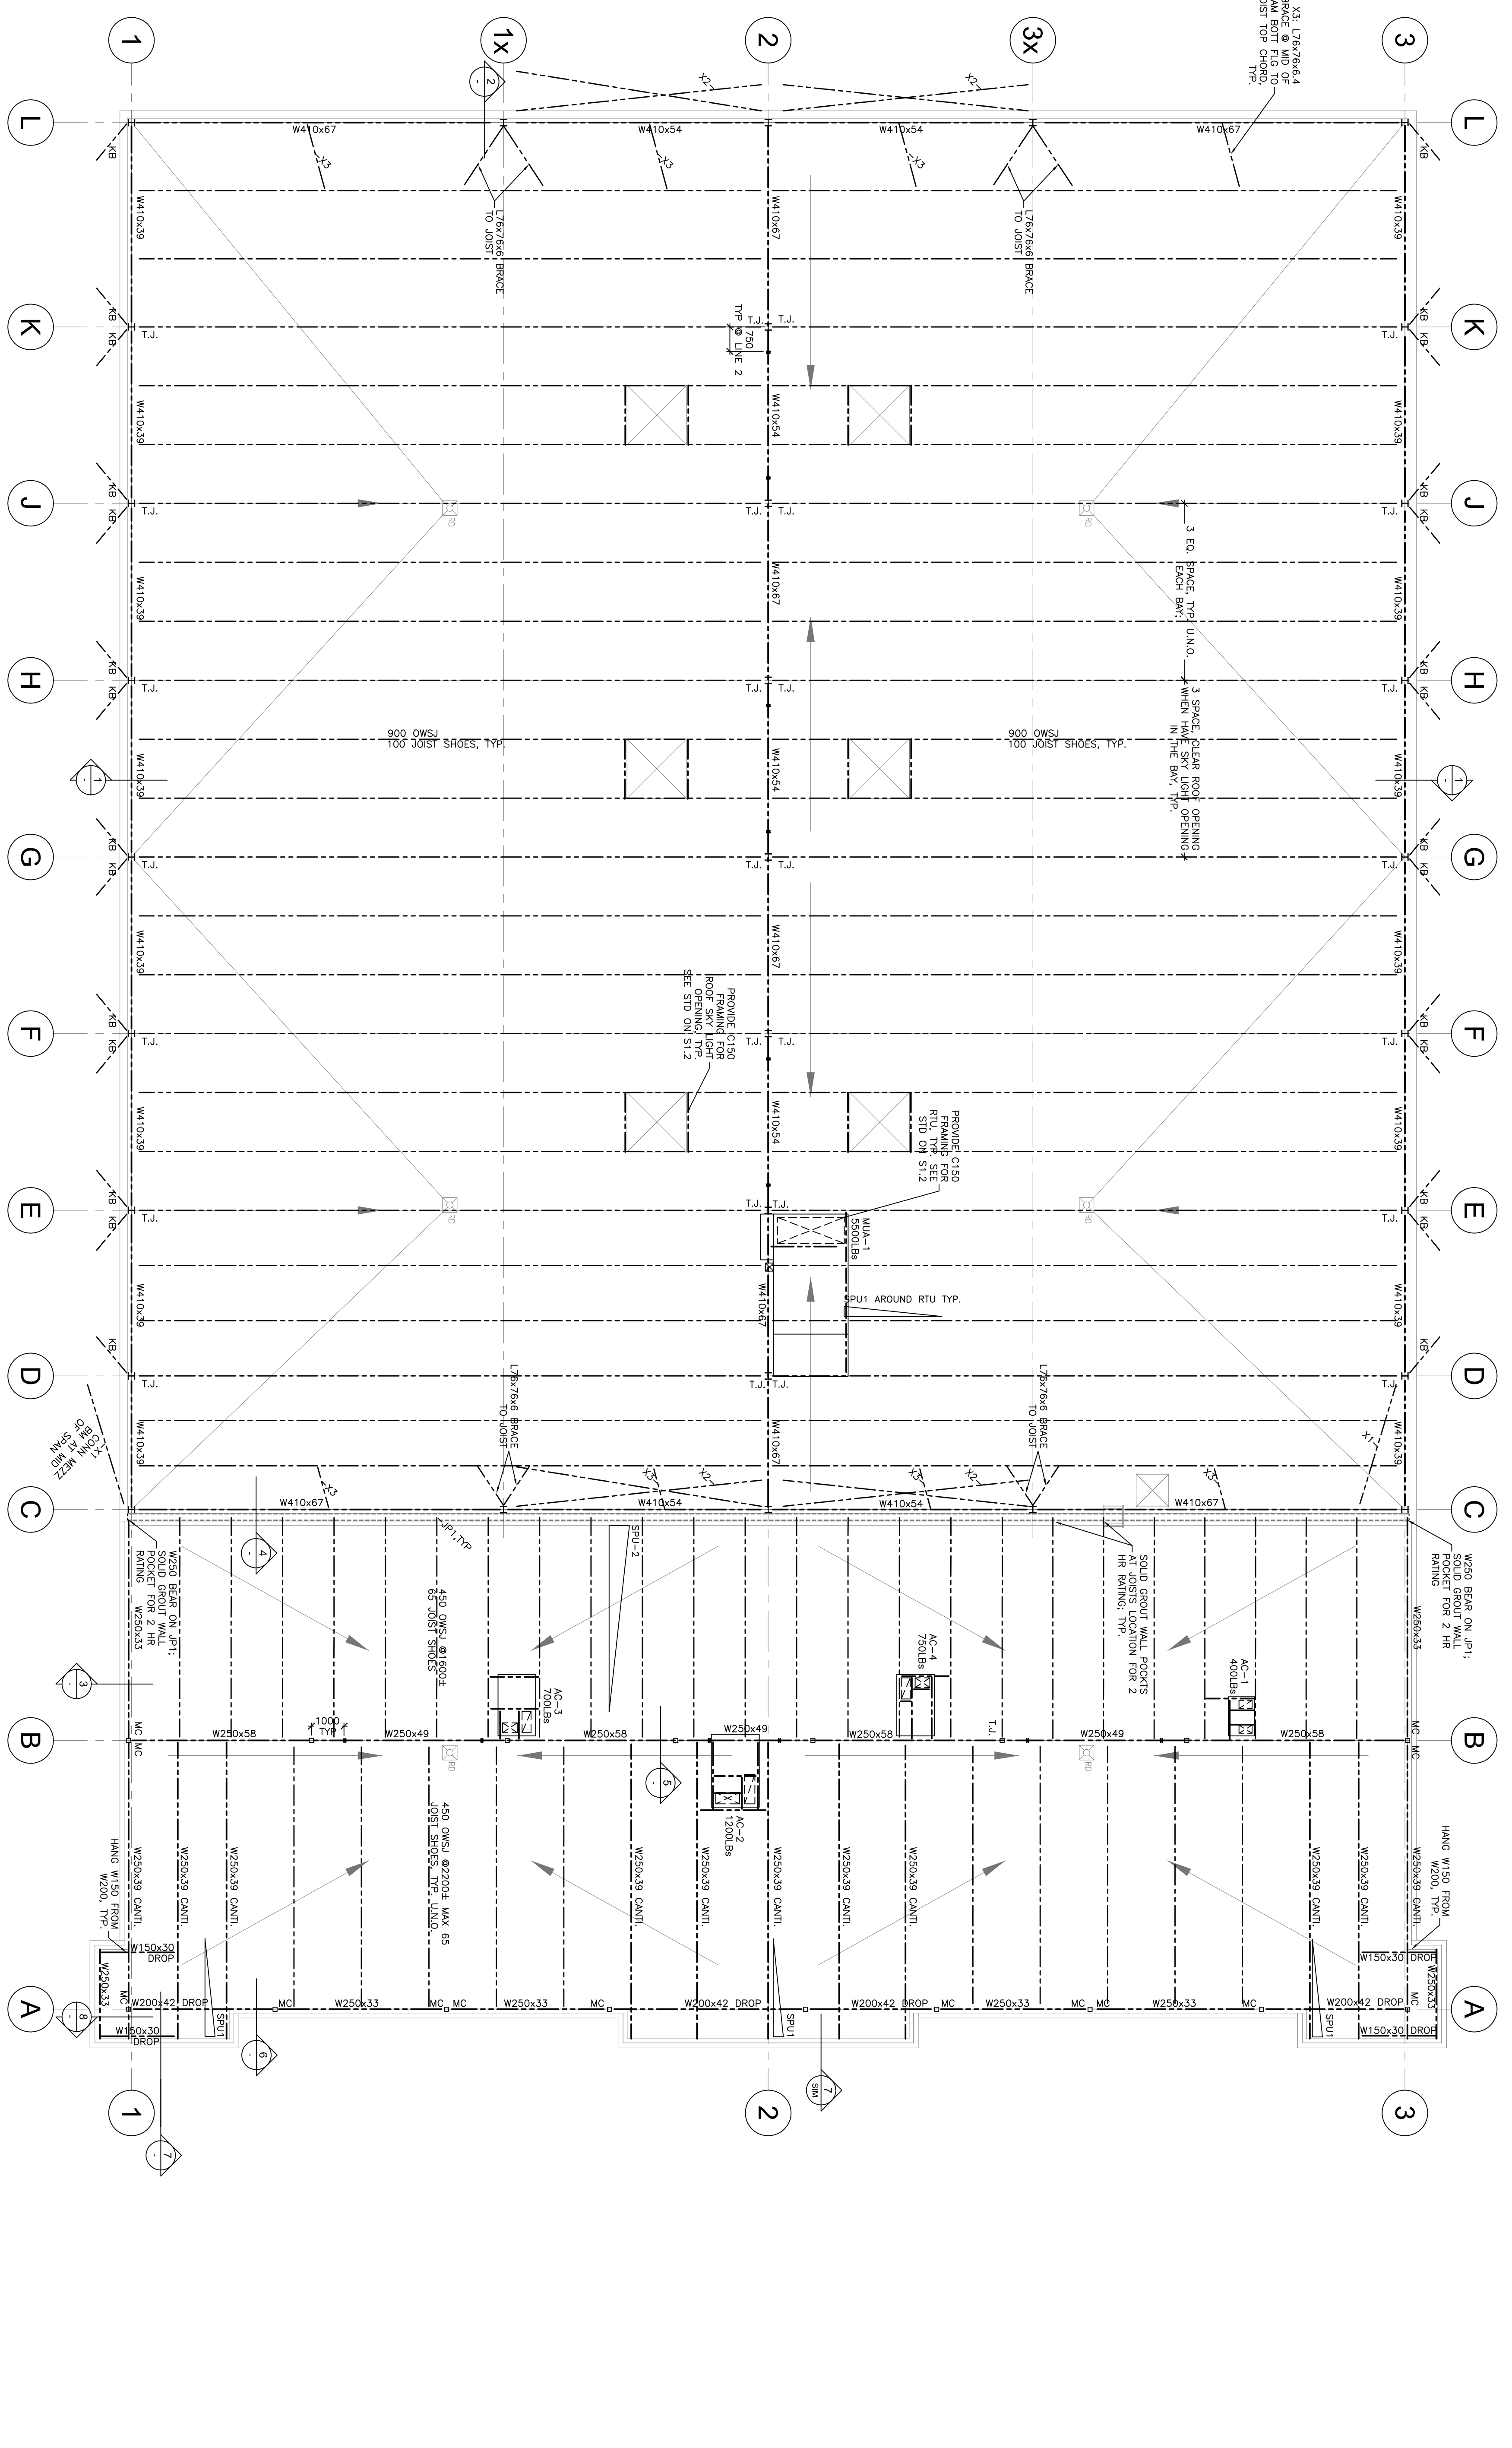

ROOF PLAN

ROOF DECK
 3840.76 METAL DECK
 PROVIDE L173x76x6 LHM AROUND DECK PERIMETER, TYPICAL

DESIGN LOADS
 DEAD LOAD: 1.2 kPa
 LIVE LOAD: 1.12 kPa + RTU + SPU

OTHERS
 X1 - DIAGONAL BRACING HS153x152x8
 X2 - VEE CROSS BRACE L152x8x13
 X3 - L76x76x6 BEAM FOOT FLG TO JOIST TOP CHORD, TYP.

MC - 50% MOMENT CONNECTION

