
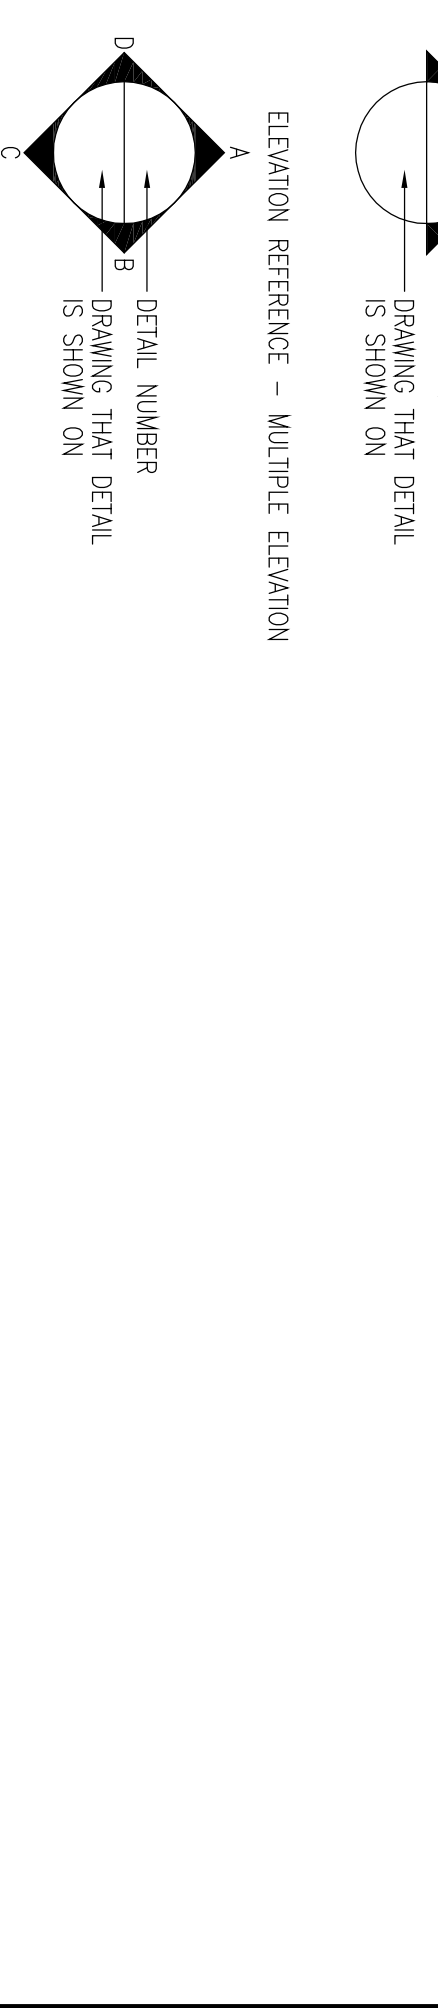
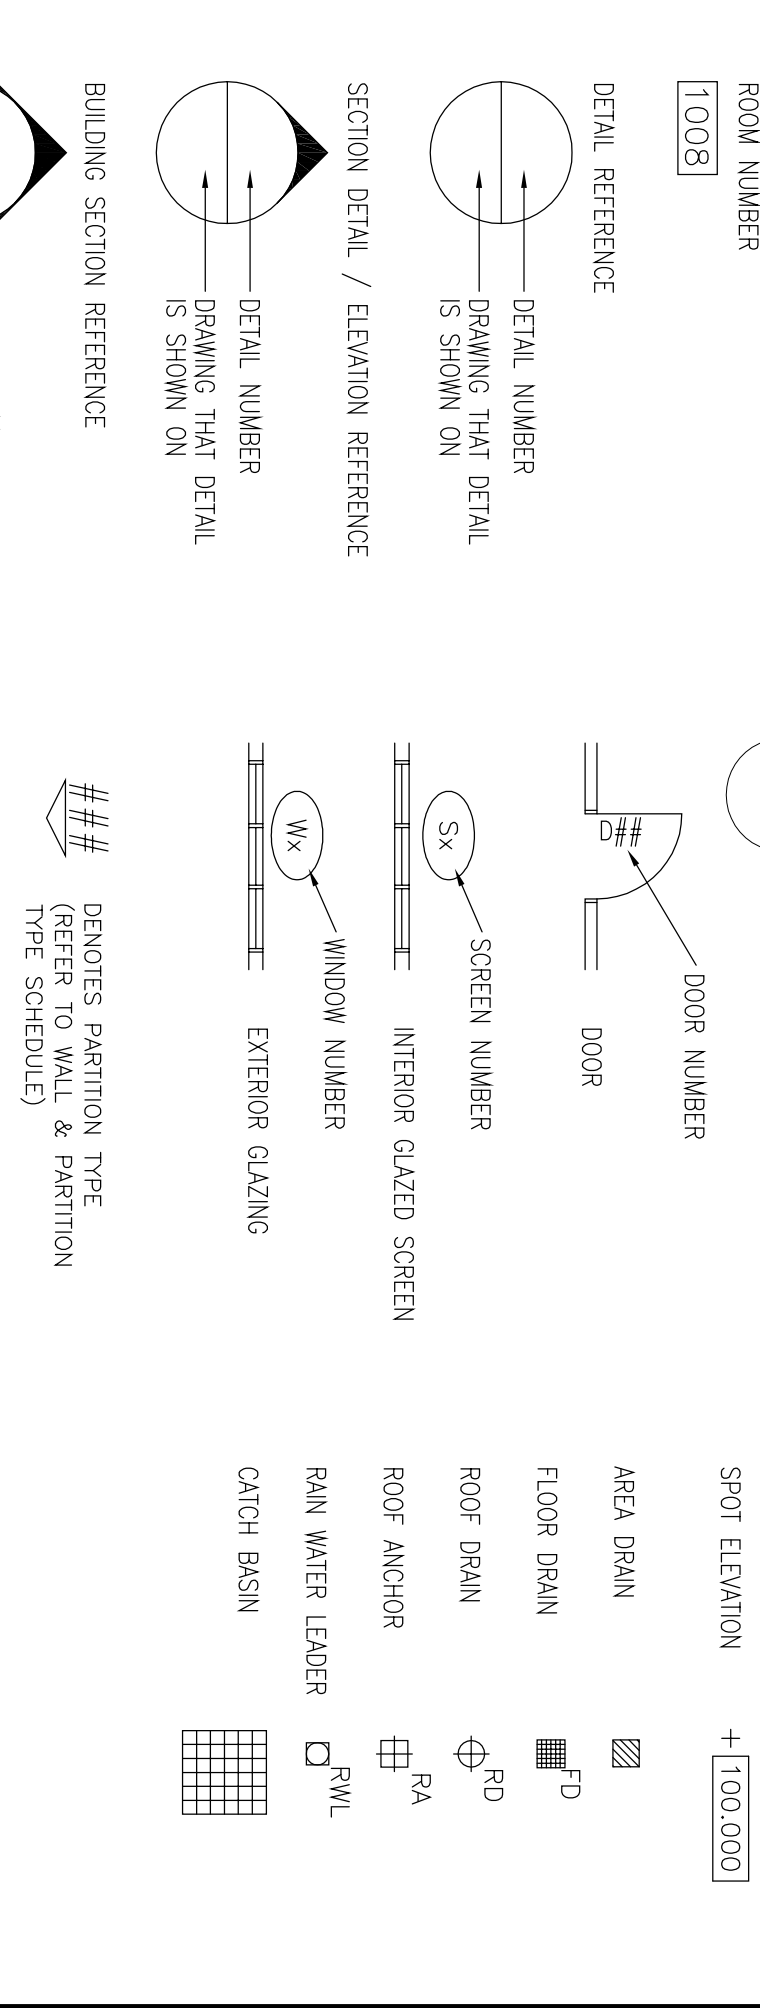


ABBREVIATIONS:			
A.T.	ACQUIC CEILING TILE (600x1200)	H.R.	HIGH RIDGE
A.F.F.	ABOVE FINISH FLOOR	I.T.D.	INTERIOR DESIGN SPECS
ALUM.	ALUMINUM	M/M	MARBLE/MIROR
B.F.	BARBER FREE	MIR	MIRROR
B.H.	BULKHEAD	ND	NO. DIM.
BLDG.	BUILDING	N.I.C.	NOT IN CONTRACT
C.H.	CEILING HEIGHT	PC	PRE-CAST CONCRETE
C.T.	CEILING TILE (STANDARD 600x600)	P.E.X.S.	PAINT EXPOSED STRUCTURE
CARP	CARPET	P.L.W.D.	PLYWOOD
CBK	CONC. BLOCK	P.M.	PAINTED MASONRY
CBY/T	CEAMIC TILE	P.M.C.	PORCELAIN TILE
CONC.	CONCRETE (C/A SEALER)	P.M.T.	PORCELAIN MOSAIC TILE
CONC.S	CONCRETE (C/A SEALER)	PRE-FIN	PRE-FINISHED
CONT	CONTINUOUS	PR	PAINT SURFACE
DBL	DOUBLE	RET	RETICULATED WALL PANEL
EL.	ELEVATION	R.T.U.	ROOF TOP UNIT
EXP.	EXPOSED STRUCTURE	S.D.	SOAP DISPENSER
EXP.S	EXPOSED STRUCTURE	S.F.L.	SAFETY FLOORING
F.F.	FINISH FLOOR	SIN	SINGLE
F.S.PRAY	FIRE-PROOF SPRAY	SPEC	SPECIFICATIONS
G.C.	GENERAL CONTRACTOR	STD.C.	STANDARD PAINT COLOUR (TO BE CONFIRMED)
GL	GLASS	TP	TOILET PAPER DISPENSER
GWB	GEORGIAN WALLBOARD	TP.	TYPICAL
HM	HOLLOW METAL		

5 ABBREVIATIONS

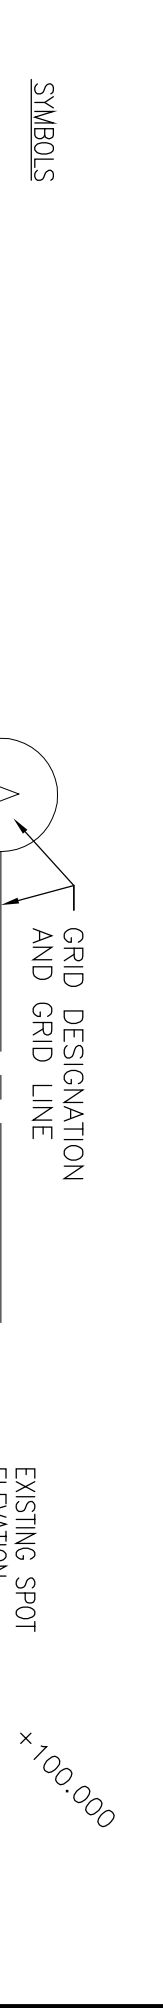

DRAWING SYMBOLS LEGEND


A001 N.T.S.

GENERAL NOTES:		
1.	ALL FIRE SEPARATIONS ARE CONTINUOUS, MAINTAIN INTEGRITY OF AND AROUND THE PERIPHERY OF THE ASSEMBLY. REFER ALSO TO A200 SERIES DRAWINGS.	
2.	CORRESPONDING LOCATIONS AND EXTENT OF LOAD BEARING SHEAR WALLS WITH STRUCTURAL DOCUMENTS.	
3.	SUBSTITUTE "BERSHIELD" OR CEMENT BOARD IN LIEU OF GYPSUM BOARD WHERE SPECIFIED. GYPSUM BOARD TO ACT AS A BED FOR THE TILE GROUT. REFER TO AND CORRESPONDING ALL WORK WITH ROOM FINISH AND COLOR SCHEDULES.	
4.	A PARTITION TYPE WITH A SUFFIX 'S' DENOTES A PARTITION WITH ACOUSTIC BATT INSULATION FOR FULL HEIGHT AND EXTENT OF PARTITION (SEE REMARKS COLUMN).	
5.	ALL STRUCTURAL AND ACOUSTICAL PARTITIONS TO EXTEND TO UNDERSIDE OF RATED CEILING ABOVE.	
6.	ABUSE-RESISTANT GYPSUM BOARD MAY BE USED FOR RESISTANCE TO IMPACT AND DAMAGE TO FINISH SURFACES. SEE ROOM FINISH SCHEDULE FOR LOCATIONS REQUIRED.	
7.	1/2" GYPSUM BOARD MAY BE SUBSTITUTED FOR 5/8" GYPSUM BOARD WHERE SPECIFIED FOR ACOUSTICAL PARTITIONS WITHIN DESIGNATED UNIT AREAS. (NOT APPLICABLE @ FIRE-RATED ASSEMBLIES)	

ASSEMBLY TYPES SCHEDULE

ASSEMBLY / PARTITION TYPE	FIRE RATING & TEST NO.	STC RATING & TEST NO.	GRAPHIC	DESCRIPTION	REMARKS
INTERIOR WALLS					
P2 / P2S	N/A	"P2S"-STICB (OBC-SG8 WOI #344 Sim.)		"P2S" 7/8" GYPSUM BOARD @ 18" O.C. -4" METAL STUDS @ 18" O.C. -1/2" GYPSUM BOARD	-FILL STUD CAVITY W/ SOUND ASSEMBLY FOR P2S -TOP BOARD ONE SIDE @ WALL CAVITIES (i.e. WASHROOMS)
P3 / P3S	N/A	"P3S"-STICB (OBC-SG8 WOI #576 Sim.)		"P3S" 7/8" GYPSUM BOARD @ 18" O.C. -6" METAL STUDS @ 18" O.C. W/ -1/2" GYPSUM BOARD	-FILL STUD CAVITY W/ SOUND ABSORB. BATT FOR "P3S" ASSEMBLIES
P3F60	N/A	N/A		"P3F60" TYPE "X" GYP. BOARD @ 18" O.C. W/ -6" METAL STUDS @ 18" O.C. W/ -1/2" TYPE "X" GYP. BOARD	PROVIDE BATT INSUL ALONG WALLS @ CORNER/LOADING/ETC & PROVIDE BATT INSUL W/ SOUND ASSEMBLY (P301.3.65RS) WALL ASSEMBLY
F1	N/A	N/A		"F1" TYPE "X" GYP. BOARD @ 18" O.C. W/ -1/2" TYPE "X" GYP. BOARD	WALL FURRING WITH BATT BATT INSUL.
EXTERIOR WALLS					
P1	N/A	N/A		1/2" GYPSUM BOARD, VAPOUR/AIR BARRIER, METAL STUDS @ 16" O.C., TILED W/ BATT INSUL.	-#R26.6(4.6RS) WALL ASSEMBLY (SEE WALL SECT. DETAILS FOR FULL DESCRIPTION)
P4	N/A	N/A		-8" CONCRETE BLOCK (PAINTED), SEE ROOM FINISH SCHEDULE	(SEE WALL SECT. DETAILS FOR FULL DESCRIPTION)
P5	N/A	N/A		-9" PRECAST SANDWICH WALL PANELS (E&F RIGID INSUL AS PER MANUF. SPECS)	-#R12(2.19RS) SEE MANUF. SPECS. (SEE WALL SECT. DETAILS FOR FULL DESCRIPTION)
** CONTRACTOR MUST PROVIDE MANUFACTURER'S CONFORMATION THAT THE SELECTED PRECAST CONCRETE PANEL WALL SYSTEM (ALONG THE NORTH ELEVATION) WILL PROVIDE THE MINIMUM 2HR FIRE-RATING REQUIRED.**					
STRUCTURAL COLUMN WRAPS					
P6	N/A	N/A		10" CONC. BLOCK TO U/A OF METAL STUDS @ 16" O.C. STEEL COLUMN (SEE STRUCT'L DWGS.)	8" CONC. BLOCK ABOVE MEZZANINE STEEL COLUMN (SEE STRUCT'L DWGS.)
ROOF ASSEMBLY					
CW120	N/A	N/A		SELF-ADHERING FIRE-RETARDANT SPRAY-FORM COVERING	-#R21(3.7RS) ROOF ASSEMBLY (SEE WALL SECT. DETAILS FOR FULL DESCRIPTION)
RF1	N/A	N/A		-GRAVEL BALLAST / BUILT-UP ROOFING MEMBRANE STRIPATE -1/4" (Min. R20) RIGID INSUL., Y/B -1/2" STEEL DECK & DWGS (SEE STRUCT'L)	

LEGEND:

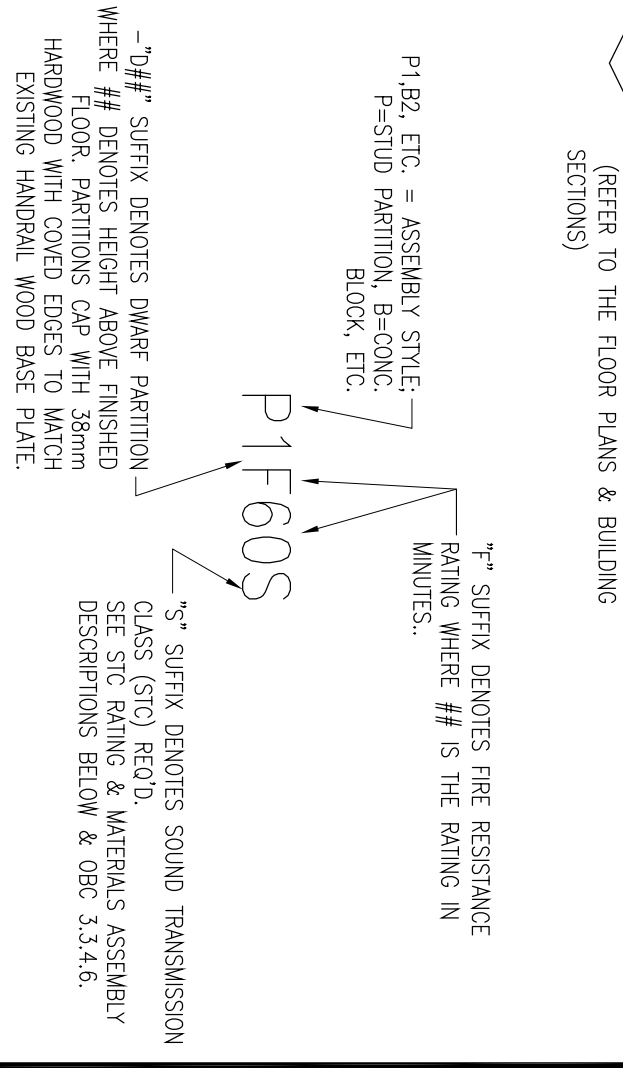

GENERAL NOTES:		
1.	WHERE ELECTRICAL AND MECHANICAL FITMENTS OCCUR ON EXISTING CEILING OR WALLS, FITMENTS SHALL BE INSTALLED IN WALLS OR CEILING. FITMENTS SHALL BE OTHERWISE ALL MECHANICAL AND ELECTRICAL FITMENTS AND SERVICES SHALL BE BUILT INTO WALLS.	
2.	MATERIAL AND FINISH FOR ALL COLUMNS SHALL BE SAME AS WALLS IN WHICH THEY OCCUR OR IF FREESTANDING, SAME AS REMAINDER OF ROOM UNLESS NOTED OTHERWISE.	
3.	GYPSUM BOARD APPLIED TO CONCRETE MASONRY UNITS OR POURED CONCRETE SHALL BE INSTALLED ON METAL FURRING UNLESS SPECIFIED OTHERWISE.	
4.	ALL DIMENSIONS, NOTED AS "A" ARE TO BE SITE VERIFIED AND VERIFIED BY THE CONTRACTOR PRIOR TO ANY CONSTRUCTION. THE CONTRACTOR TO ADVISE THE ARCHITECT (IN ADVANCE) IN WRITING OF DEVIATIONS (SITE CONDITIONS) FROM EXISTING BASE BUILDING DRAWING INFORMATION PROVIDED TO DESIGNER BY BUILDING OWNER. ADVISE DESIGNER FOR COORDINATION OF WORK.	
5.	DIMENSIONS TO INTERIOR PARTITIONS ARE TO FACE OF GYPSUM BOARD, FACE OF CONCRETE MASONRY UNIT OR FACE OF POURED CONCRETE UNLESS NOTED OTHERWISE.	
6.	WALL PARTITIONS ARE INDICATED WITH A "P" FOLLOWED BY A NUMBER. SEE PARTITION TYPES FOR PARTITION COMPONENTS.	
7.	ALL EXTERIOR EXPOSED STEEL TO BE HOT DIPPED GALVANIZED. THIS INCLUDES BOTH STRUCTURAL AND MISCELLANEOUS STEEL.	
8.	ALL CONSTRUCTION SHALL CONFORM TO THE LATEST PRINTING OF ONTARIO BUILDING CODE.	
9.	ALL FITMENTS (I.E. DOORS, WINDOWS, SCREENS, CASEWORK, ETC.) SHALL BE INSTALLED IN ACCORDANCE WITH MANUFACTURER'S SPECIFICATIONS AND STANDARDS.	
10.	ONLY THE SHOP DRAWINGS REQUESTED IN THE SPECIFICATION, WILL BE REVIEWED.	
11.	ALL FIRE RATED PARTITIONS ARE TO EXTEND TO U/S OF STRUCTURE	
12.	REFER TO SECTION AND DETAILS FOR EXTERIOR WALL SYSTEM MATERIALS.	

GENERAL NOTES

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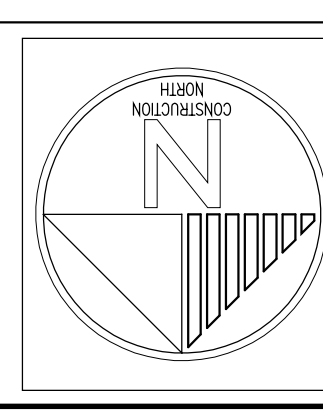
GENERAL NOTES

ARCHITECTURAL	
A001	TILE SHEET
A001	SYMBOLS, LEGENDS, MISC. DETAILS & ASSEMBLY TYPES
A100	SITE PLAN
A200	CODE ANALYSIS, BARRIER-FREE DESIGN, MATRIX
A201	FIRE SEPARATIONS
A301	OVERALL GROUND FLOOR
A302	MEZZANINE & ROOF PLAN
A303	PARTIAL GROUND PLAN BLOW-UP
A304	PARTIAL GROUND PLAN BLOW-UP
A320	REFLECTED CEILING PLAN
EXTERIOR ELEVATIONS	
A400	
A500	CROSS SECTIONS
A501	WALL SECTIONS
A502	WALL SECTIONS & DETAILS
A503	ROOF ACCESS LADDER DETAILS
A504	DOOR & WINDOW SCHEDULES
A600	
A700	INTERIOR WALL ELEVATIONS

ARCHITECTURAL DRAWING LIST

A001 N.T.S.

NO.	DATE	DESCRIPTION
1.	APR/10	ISSUED FOR REVIEW
2.	MAY/10	ISSUED FOR TENDER
3.		
4.		
5.		
6.		
7.		
8.		
9.		
10.		



STATUS:	DESIGN
REVIEW:	REVISION
SITE PLAN:	ISSUED FOR TENDER
TENDER:	
PERMIT:	
CONSTRUCTION:	
OTHER:	

PROJECT NAME:	ATTRIDGE TRANSPORT NEW OFFICES
DRAWING NAME:	SYMBOLS, LEGENDS, MISC. DETAILS & ASSEMBLY TYPES
PROJECT NO.:	09004
DATE:	APR. 10
SCALE:	AS NOTED
DESIGNER:	FABIANI ARCHITECT LTD.
DATE:	APR. 10

PROJECT NAME: ATTRIDGE TRANSPORT NEW OFFICES

DRAWING NAME: SYMBOLS, LEGENDS, MISC. DETAILS & ASSEMBLY TYPES

PROJECT NO.: 09004

DATE: APR. 10

SCALE: AS NOTED

DESIGNER: FABIANI ARCHITECT LTD.

DATE: APR. 10

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DESIGNER: FABIANI ARCHITECT LTD.

DATE: APR. 10